


61'-1"

51'-10 1/4"

101'-6"


A2 BASEMENT PLAN
SCALE: 1" = 4'-0"

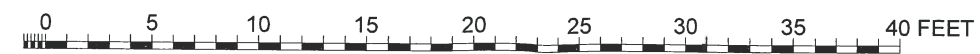


Ex. A.11

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SCALE:	
FILE NAME:	

SHEET NO. **A1.1**
OF

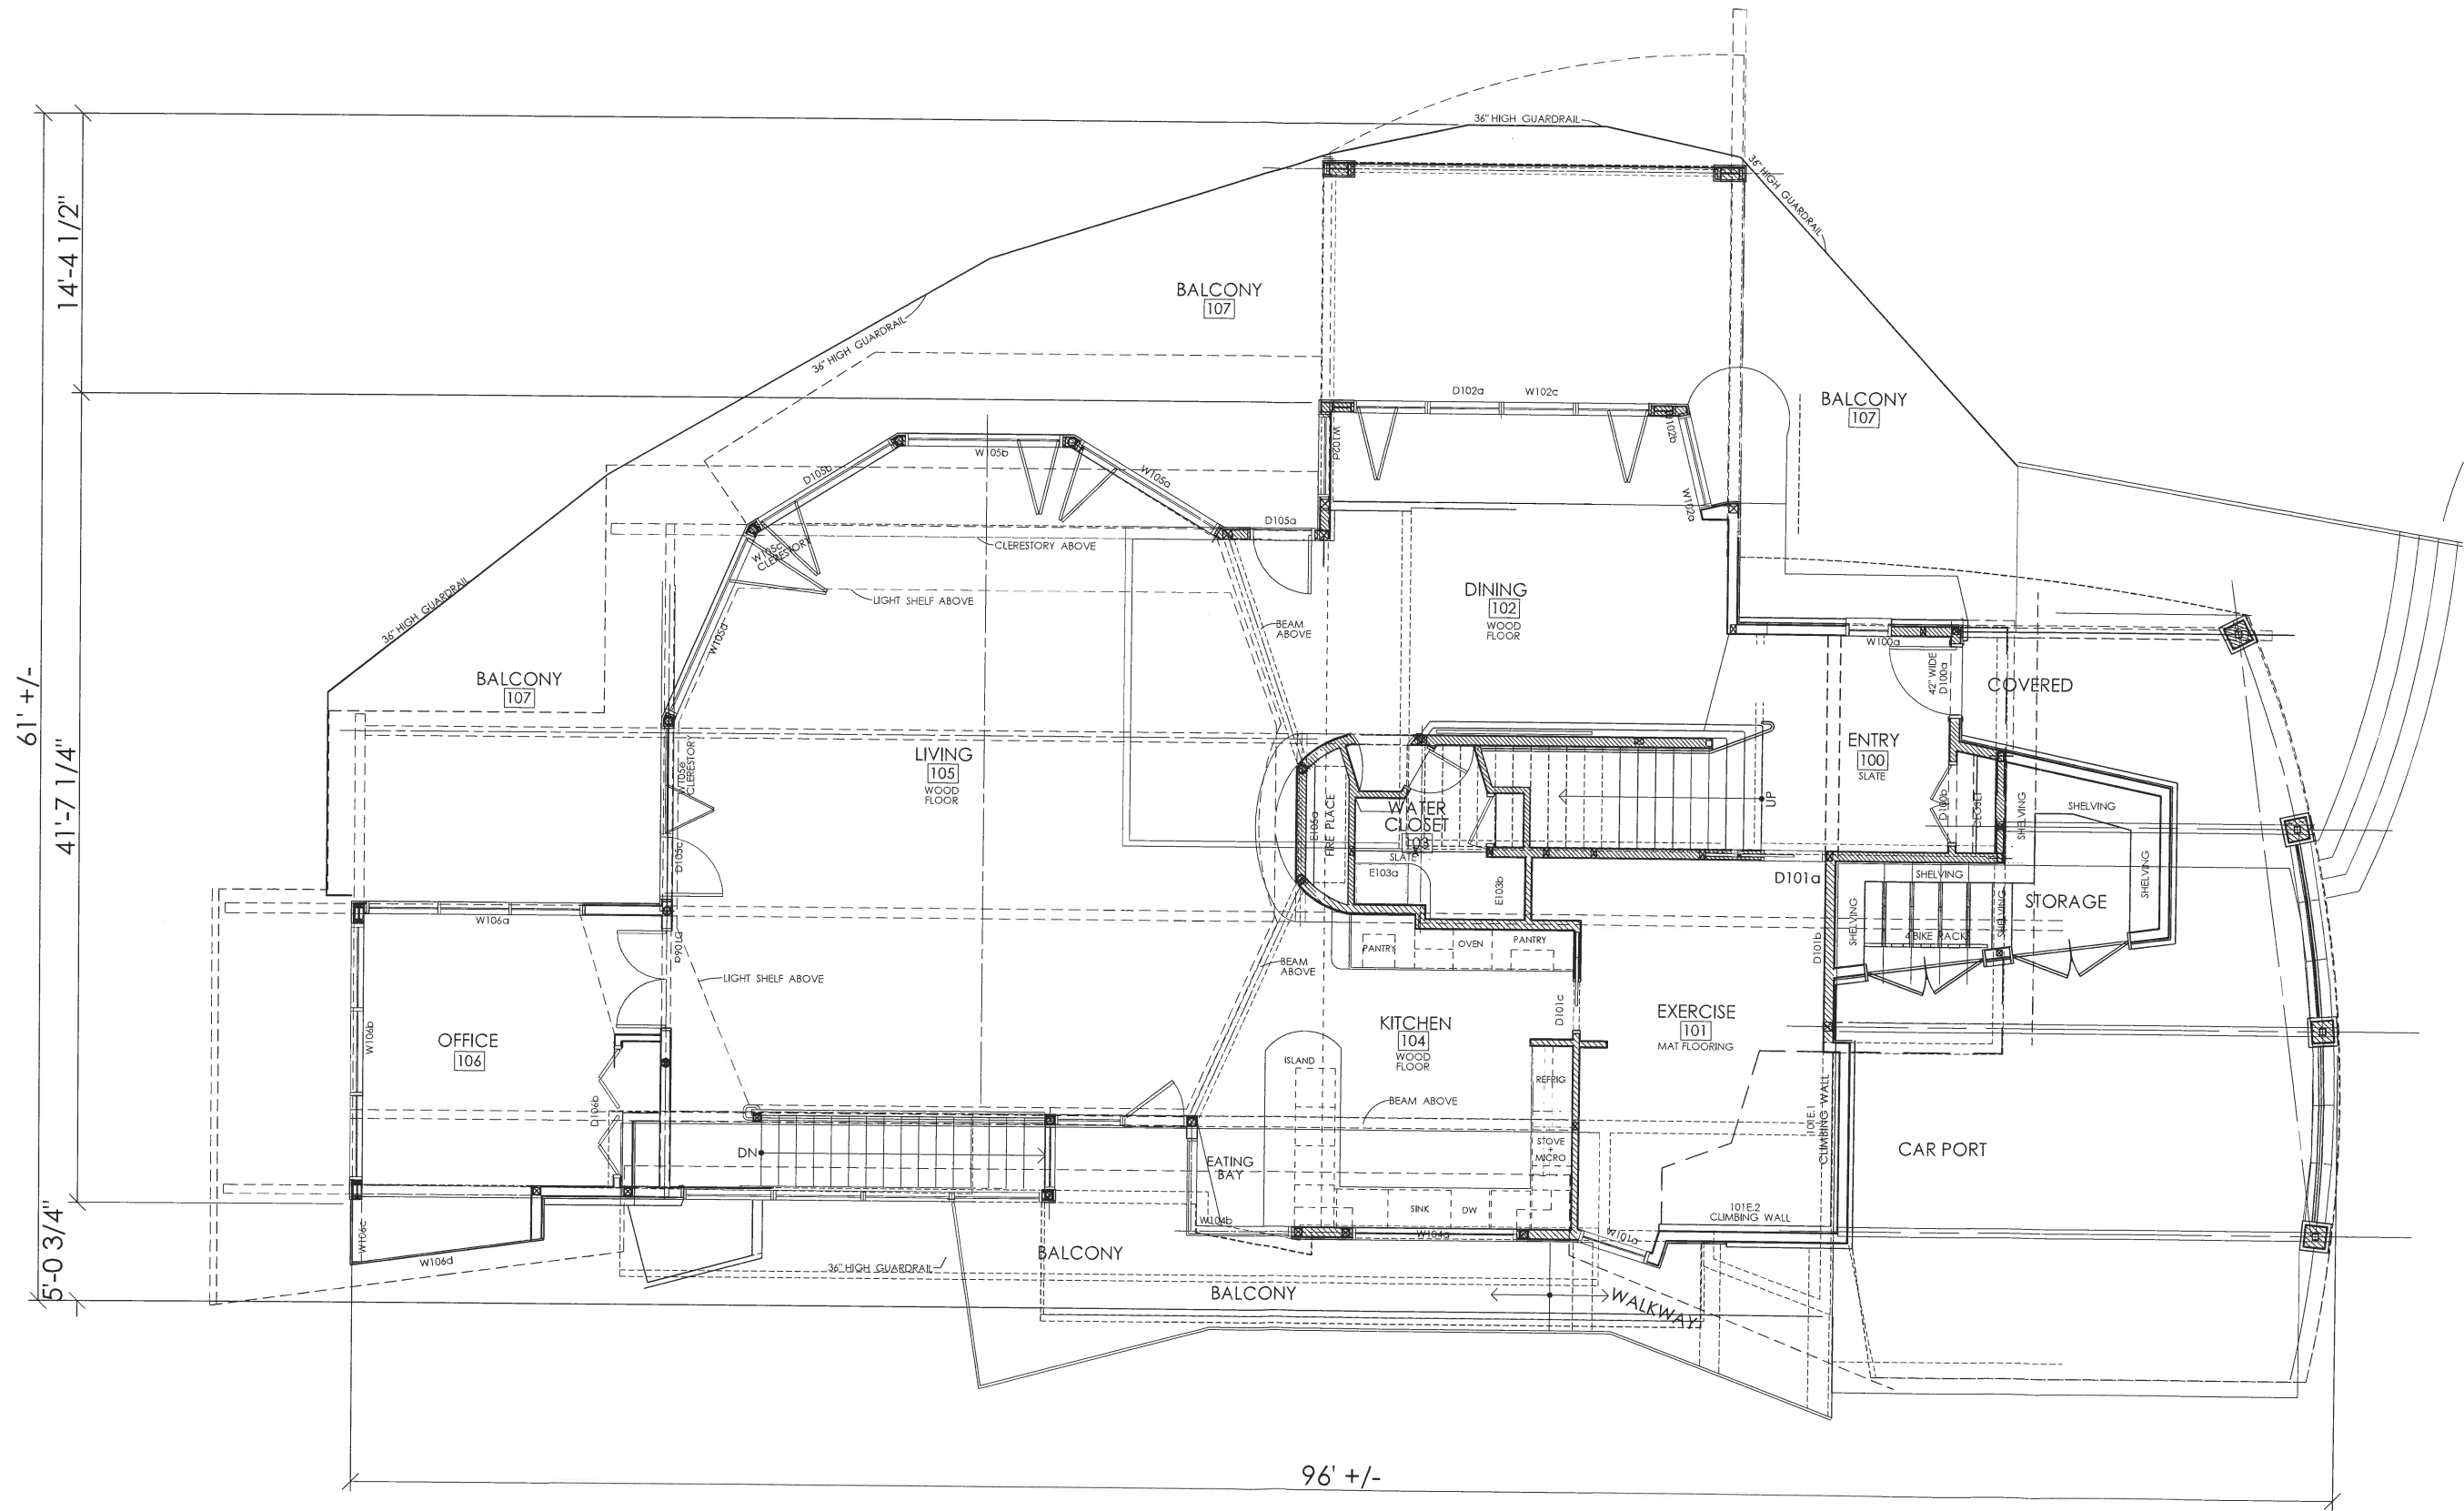

A1 MAIN FLOOR PLAN
SCALE: 1" = 4'-0"

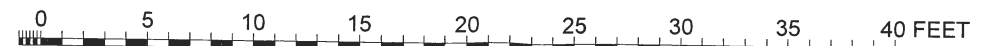


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SCALE:

FILE NAME:

SHEET NO. **A1.2**
OF




UPPER FLOOR PLAN
SCALE: 1/4" = 1'-0"

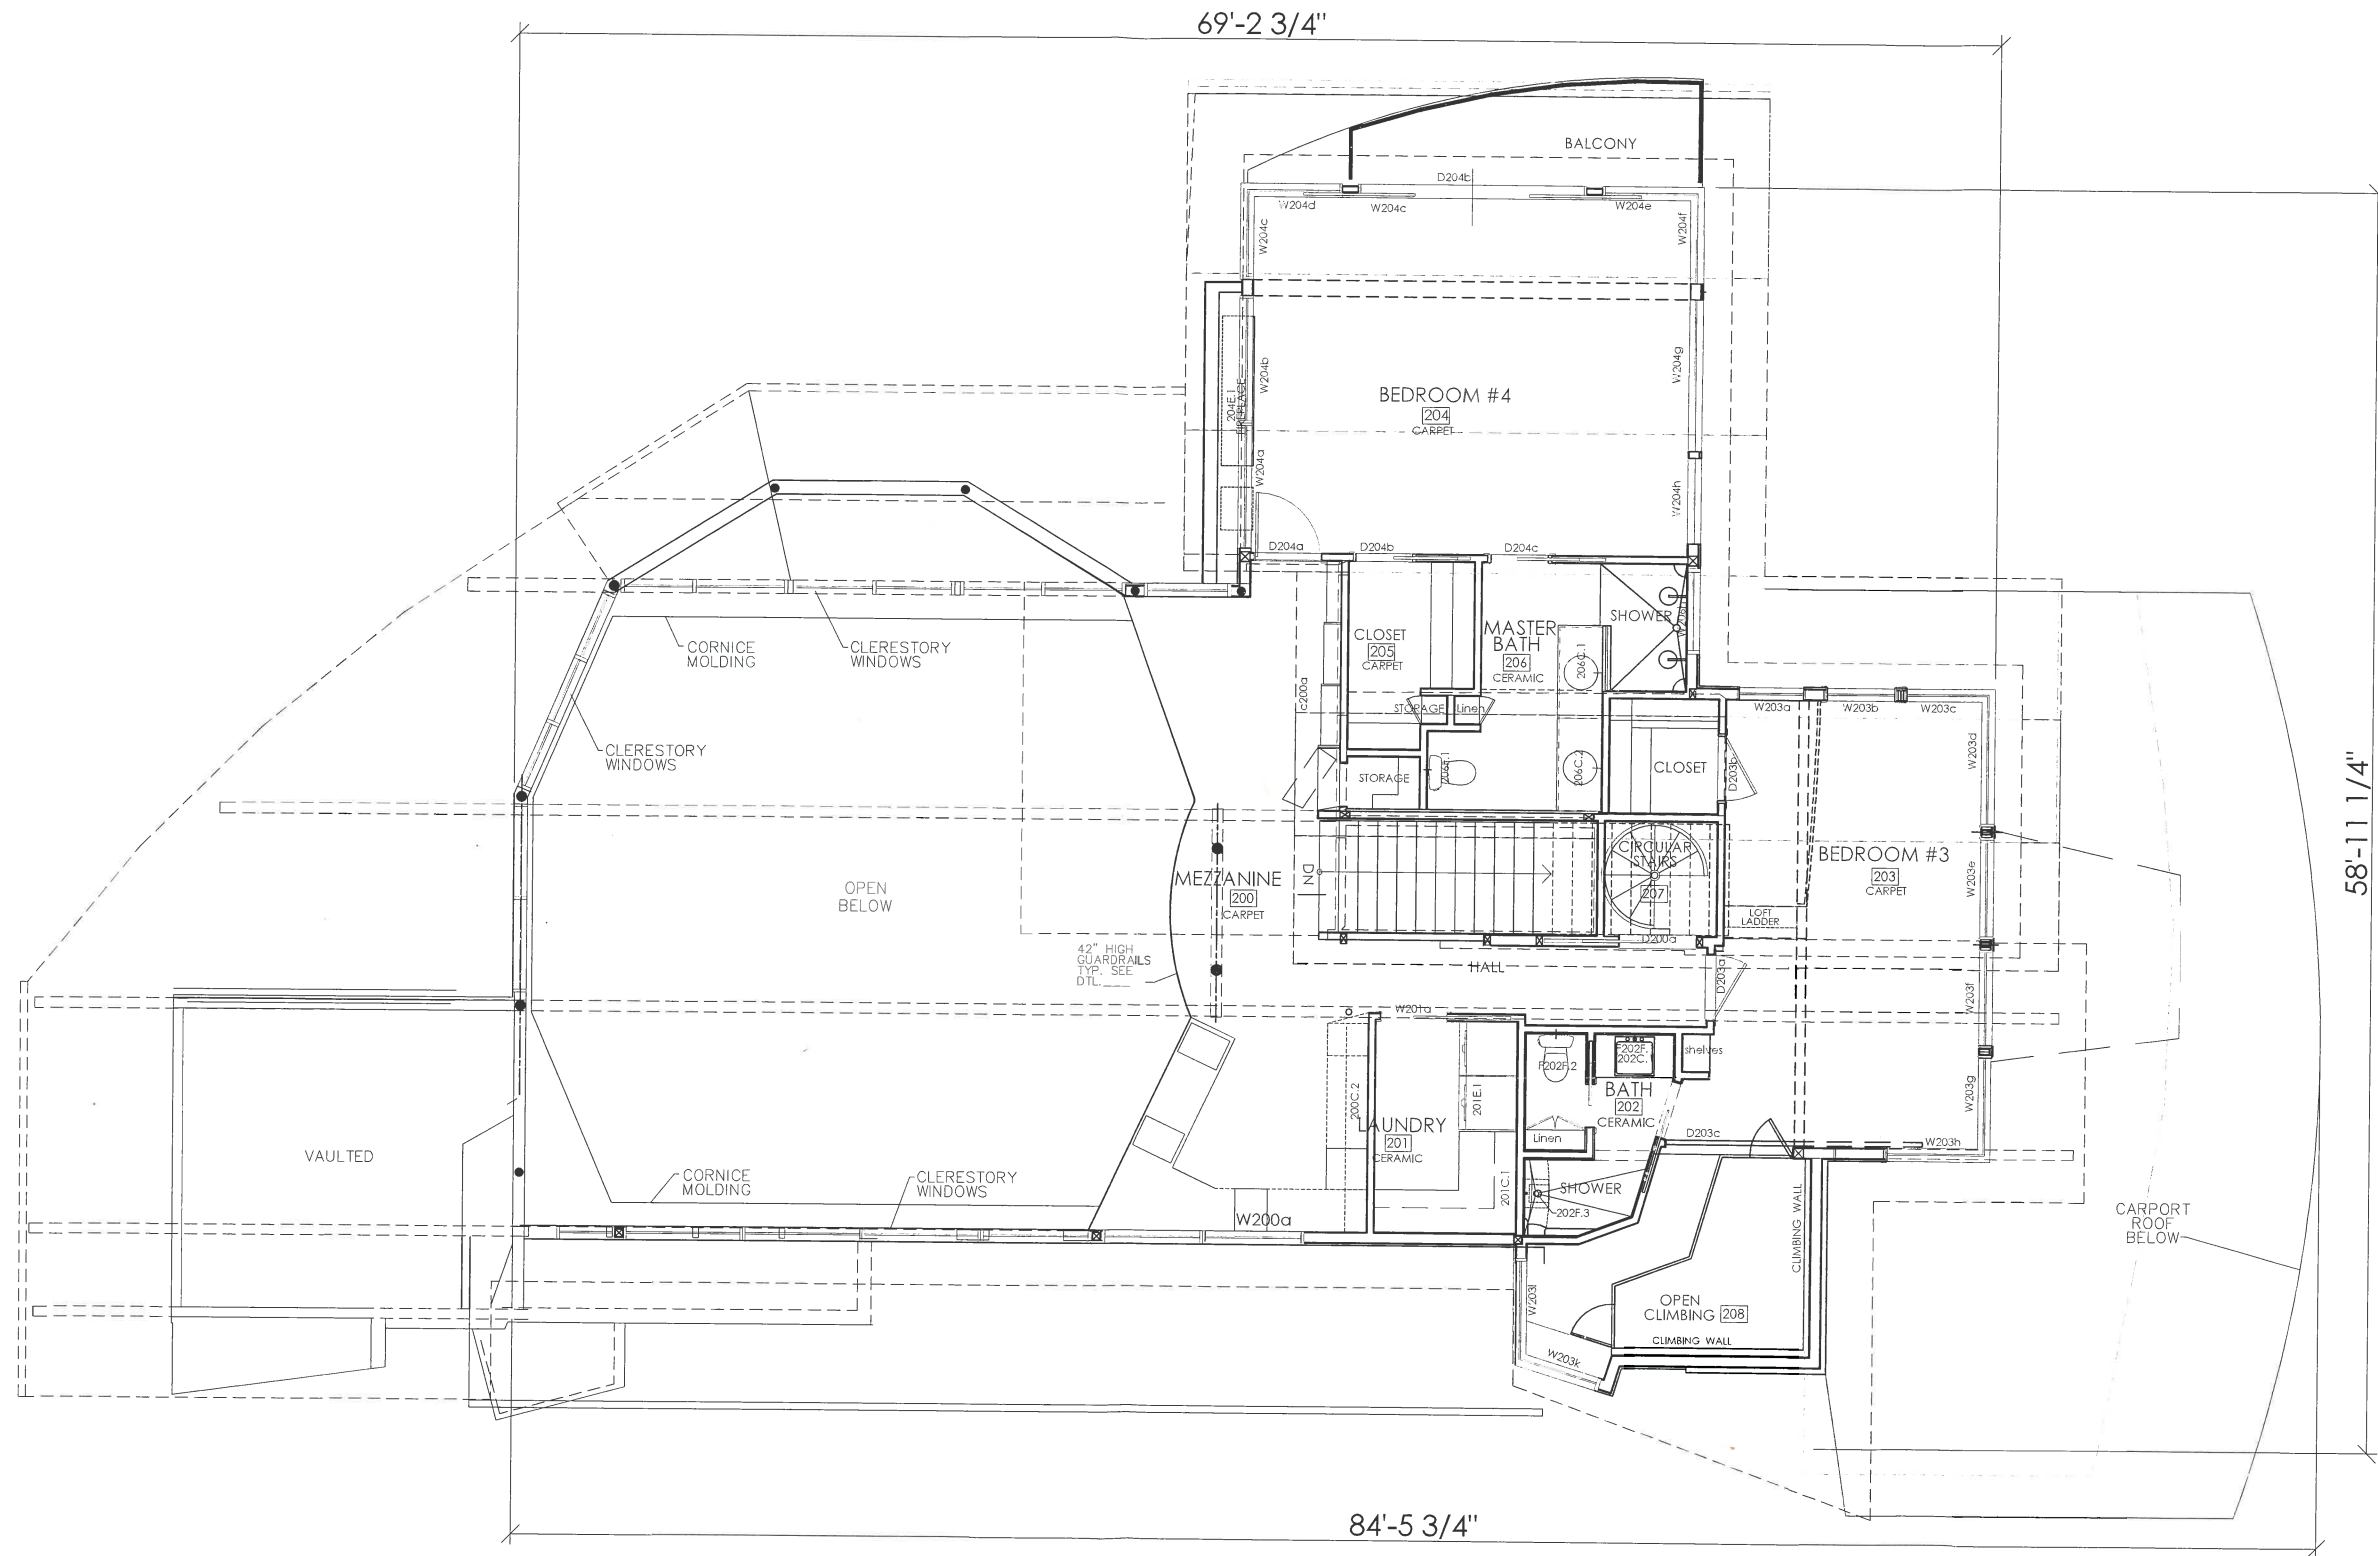

DESIGN DATE: 4 DEC 2019


DRAWN BY: CAL
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FILE NAME:

SHEET NO. **A1.3**
OF

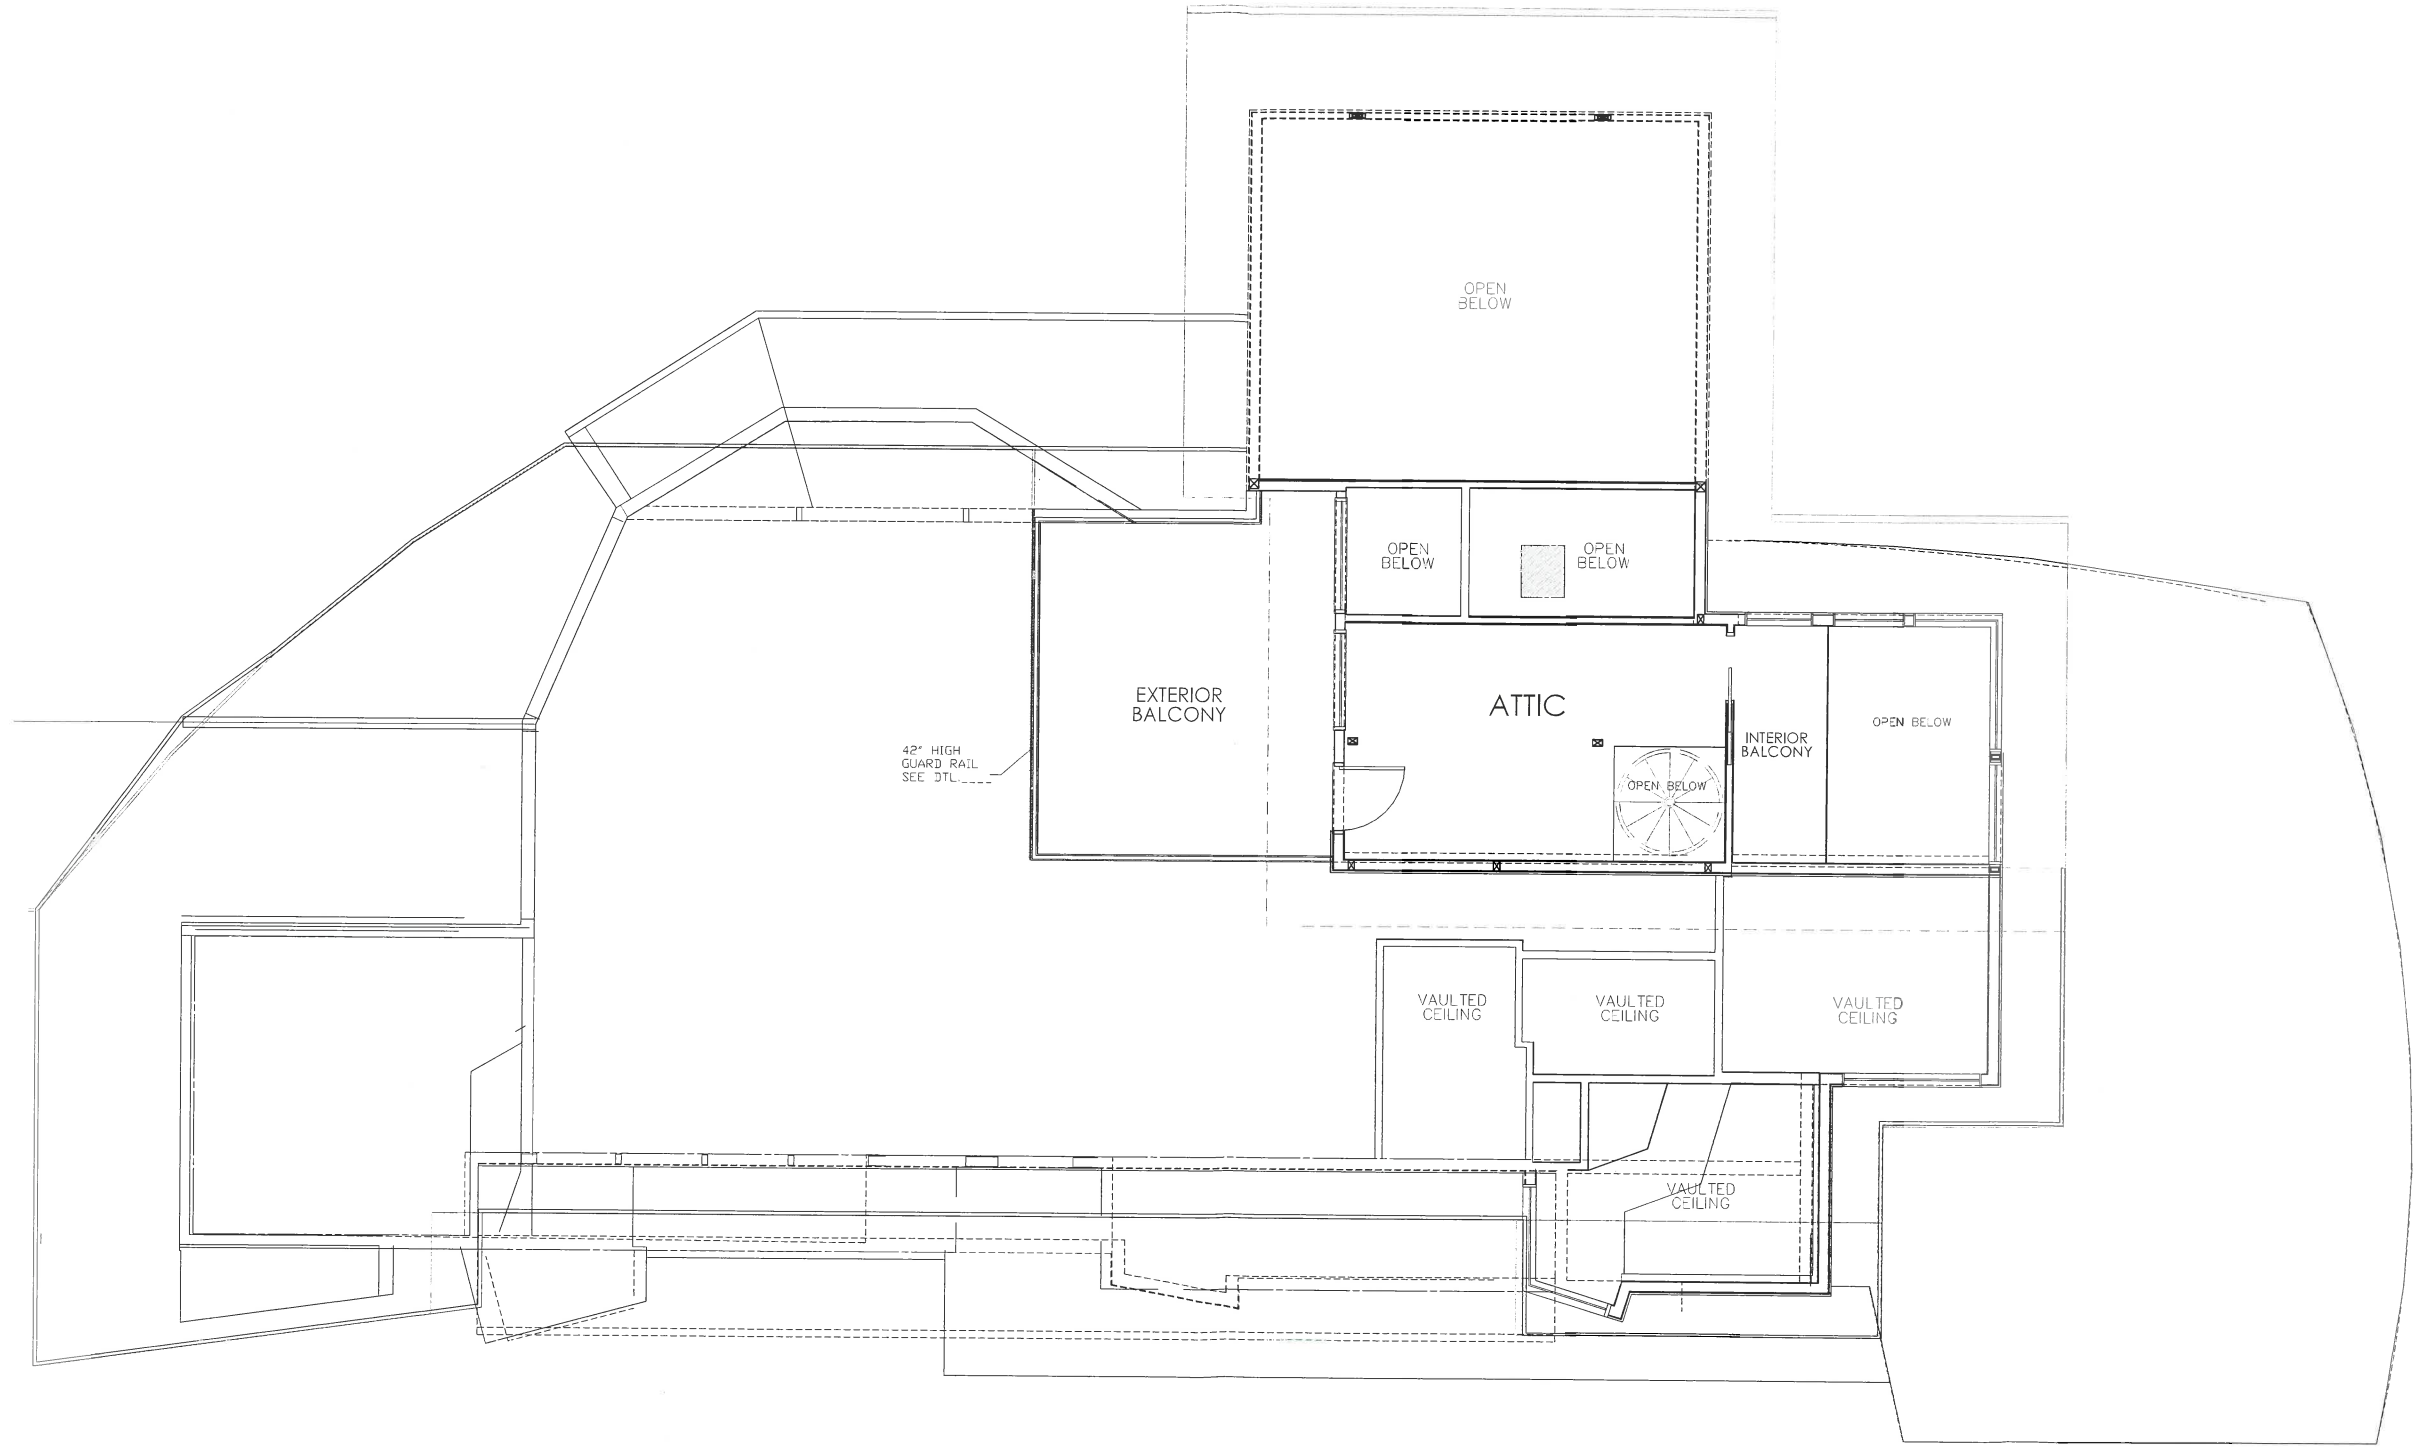



WAIBLINGER RESIDENCE
13195 NW Mamee Rd.
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FILE NAME:	

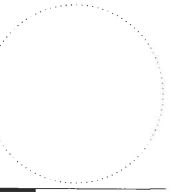


A4 ATTIC ROOF PLAN
SCALE 1/4" = 1'-0"



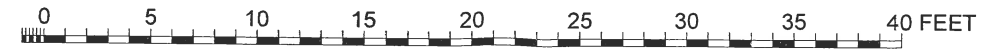

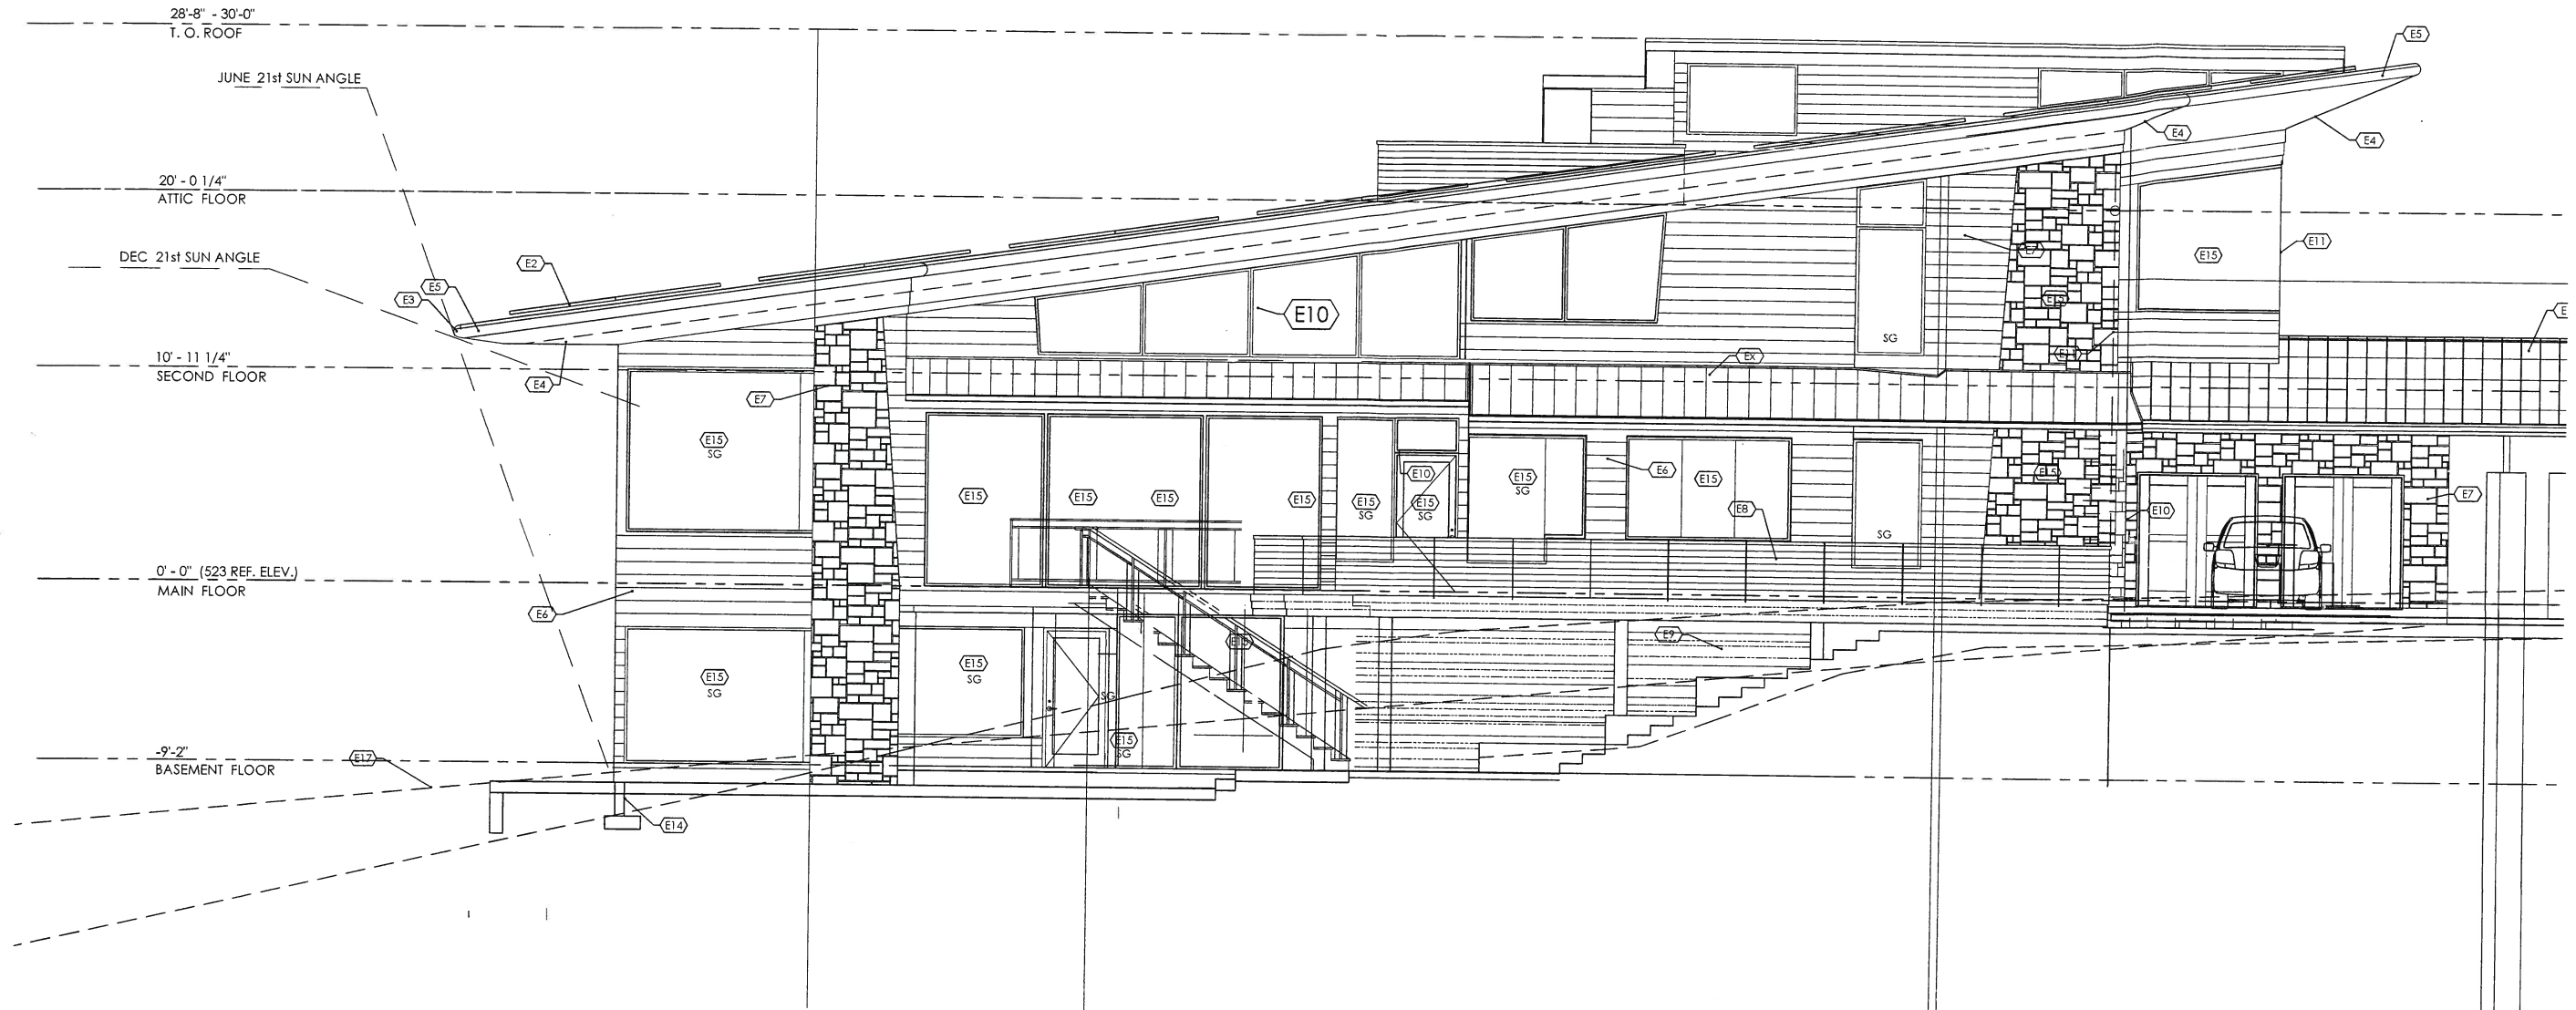EAST ELEVATION
SCALE: 1/4" = 1' - 0"

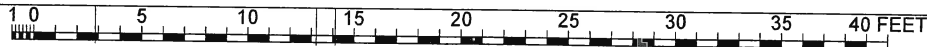

LEGEND

- E1. STANDING SEAM METAL ROOF TYP.
- E2. PHOTO VOLTIC PANELS SEE & # TBD.
- E3. CUSTOM METAL GUTTER / FASCIA DTL.
- E4. FIBER CEMENT SOFFIT DTL. W/ DRY PIPE FIRE SPRINKLER SYSTEM.
- E5. METAL & FIBER CEMENT RAKE. W/ EQUALLY SPACED JOINTS.
- E6. FIBER CEMENT RAIN SCREEN.
- E7. RANDOM ASHLAR SYNTHETIC STONE VENEER.
- E8. 42" HIGH GUARDRAIL W/ WIRE ROPE AT 3 1/2" O/C. SEE DTL.
- E9. OFF FORM CONCRETE WALL.
- E10. PREMANUF. METAL FRAME DOOR & WINDOW SYSTEM TYP.
- E11. BUTT GLAZED WINDOWS WHERE SHOWN.
- E12. SG = SAFETY GLAZING WHERE SHOWN.


- E13. EXTRUDED ALUMINUM TRELLIS SYSTEM. SEE DTL.
- E14. BELOW GRADE FOUNDATION WORK SHOWN DASHED TYP.
- E15. REFLECTIVE PRIVACY GLAZING WHERE SHOWN.
- E16. STRUCTURAL BEAM W/ DRIP FLASHING FINISH TBD.
- E17. EXISTING GRADE AT BUILDING CENTER SHOWN DASHED.
- E18. 9'-0" X 7'-0" GARAGE DOOR.
- E19. 7'-0" X 7'-0" GARAGE DOOR.
- E20. 6" HIGH MAX. LANDSCAPE RETAINING WALLS WITH OFF FORM CONCRETE FINISH TYP. W/ STONE CAPS WHERE SHOWN.
- E21. LANDSCAPE STAIRS & FEATURE WALLS W/ STONE CAPS TBD.
- E22. MATCH EXISTING DECK MATERIAL & DIRECTION.
- E23. STEEL MOMENT FRAME.
- E24. STEEL MOMENT FRAME.
- E25. WOOD OR STEEL BRACKET SYSTEM.

DESIGN DATE: 4 DEC 2019

DRAWN BY: CAL


SCALE:

FILE NAME:

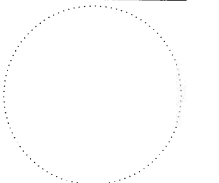

SHEET NO. A6

OF

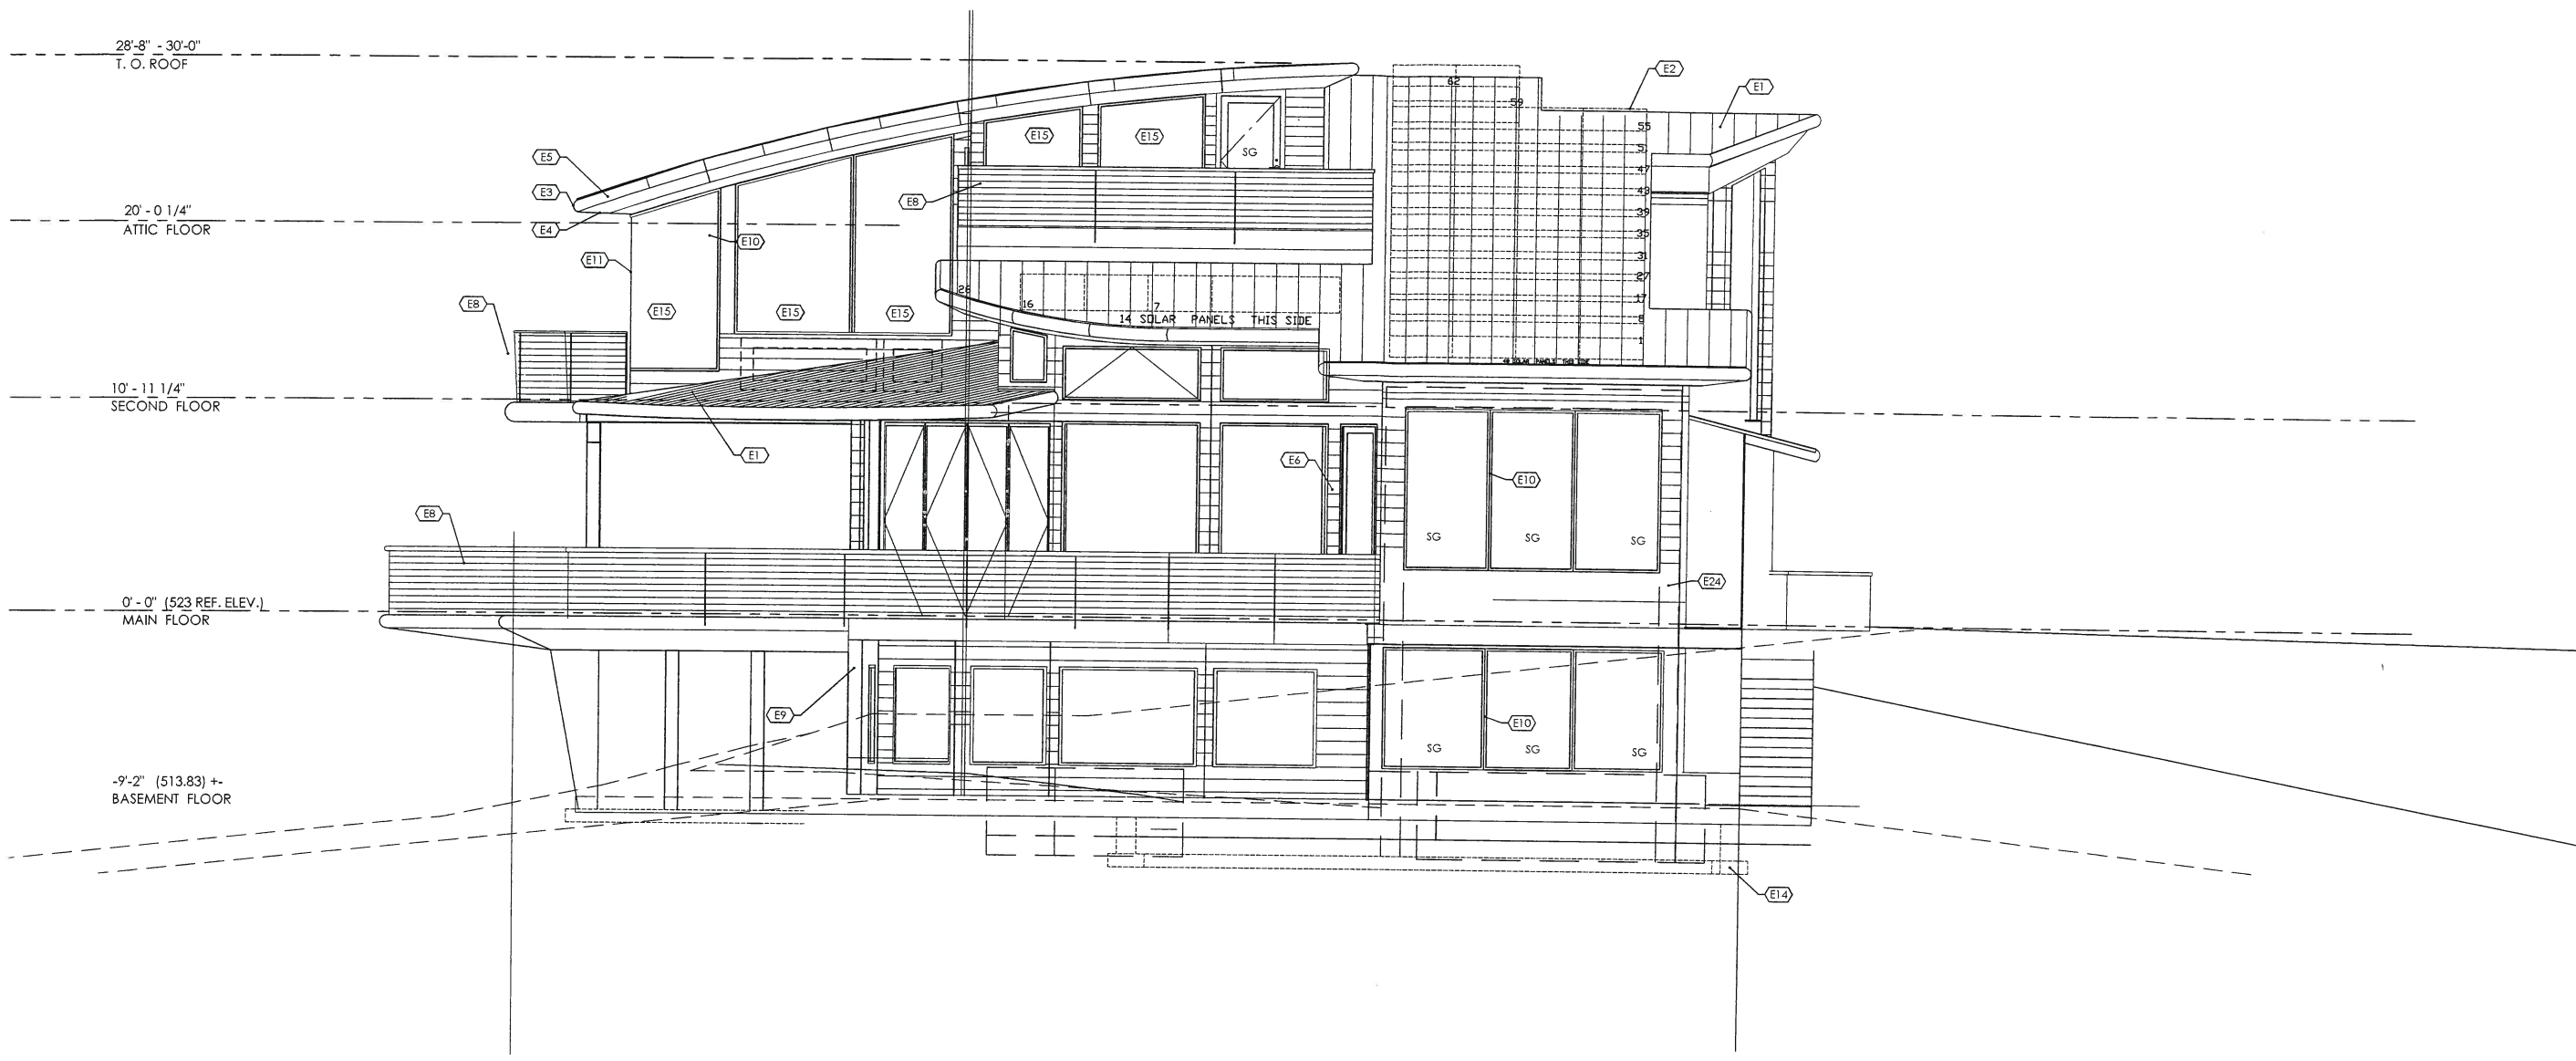

SOUTH ELEVATION
SCALE: 1/4" = 1' - 0"



LEGEND

- E1. STANDING SEAM METAL ROOF TYP.
- E2. PHOTO VOLTIC PANELS SIZE & # TBD.
- E3. CUSTOM METAL GUTTER / FASCIA DTL.
- E4. FIBER CEMENT SOFFIT DTL W/ DRY PIPE FIRE SPRINKLER SYSTEM.
- E5. METAL & FIBER CEMENT RAKE, W/ EQUALLY SPACED JOINTS.
- E6. FIBER CEMENT RAIN SCREEN.
- E7. RANDOM ASHLAR SYNTHETIC STONE VENEER.
- E8. 42" HIGH GUARDRAIL W/ WIRE ROPE AT 3 1/2" O/C. SEE DTL.
- E9. OFF FORM CONCRETE WALL.
- E10. PREMANUF. METAL FRAME DOOR & WINDOW SYSTEM TYP.
- E11. BUTT GLAZED WINDOWS WHERE SHOWN.
- E12. SG = SAFETY GLAZING WHERE SHOWN.


- E13. EXTRUDED ALUMINUM TRELLIS SYSTEM SEE DTL.
- E14. BELOW GRADE FOUNDATION WORK SHOWN DASHED TYP.
- E15. REFLECTIVE PRIVACY GLAZING WHERE SHOWN.
- E16. STRUCTURAL BEAM W/ DRIP FLASHING FINISH TBD.
- E17. EXISTING GRADE AT BUILDING CENTER SHOWN DASHED.
- E18. 9'-0" X 7'-0" GARAGE DOOR.
- E19. 7'-0" X 7'-0" GARAGE DOOR.
- E20. 6' HIGH MAX. LANDSCAPE RETAINING WALLS WITH OFF FORM CONCRETE FINISH TYP. W/ STONE CAPS WHERE SHOWN.
- E21. LANDSCAPE STAIRS & FEATURE WALLS W/ STONE CAPS TBD.
- E23. MATCH EXISTING DECK MATERIAL & DIRECTION.
- E24. STEEL MOMENT FRAME

DESIGN DATE: 4 DEC 2019

DRAWN BY: CAL


SCALE:

FILE NAME:

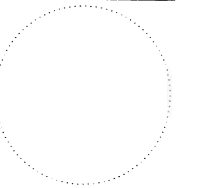


SHEET NO. A7

OF

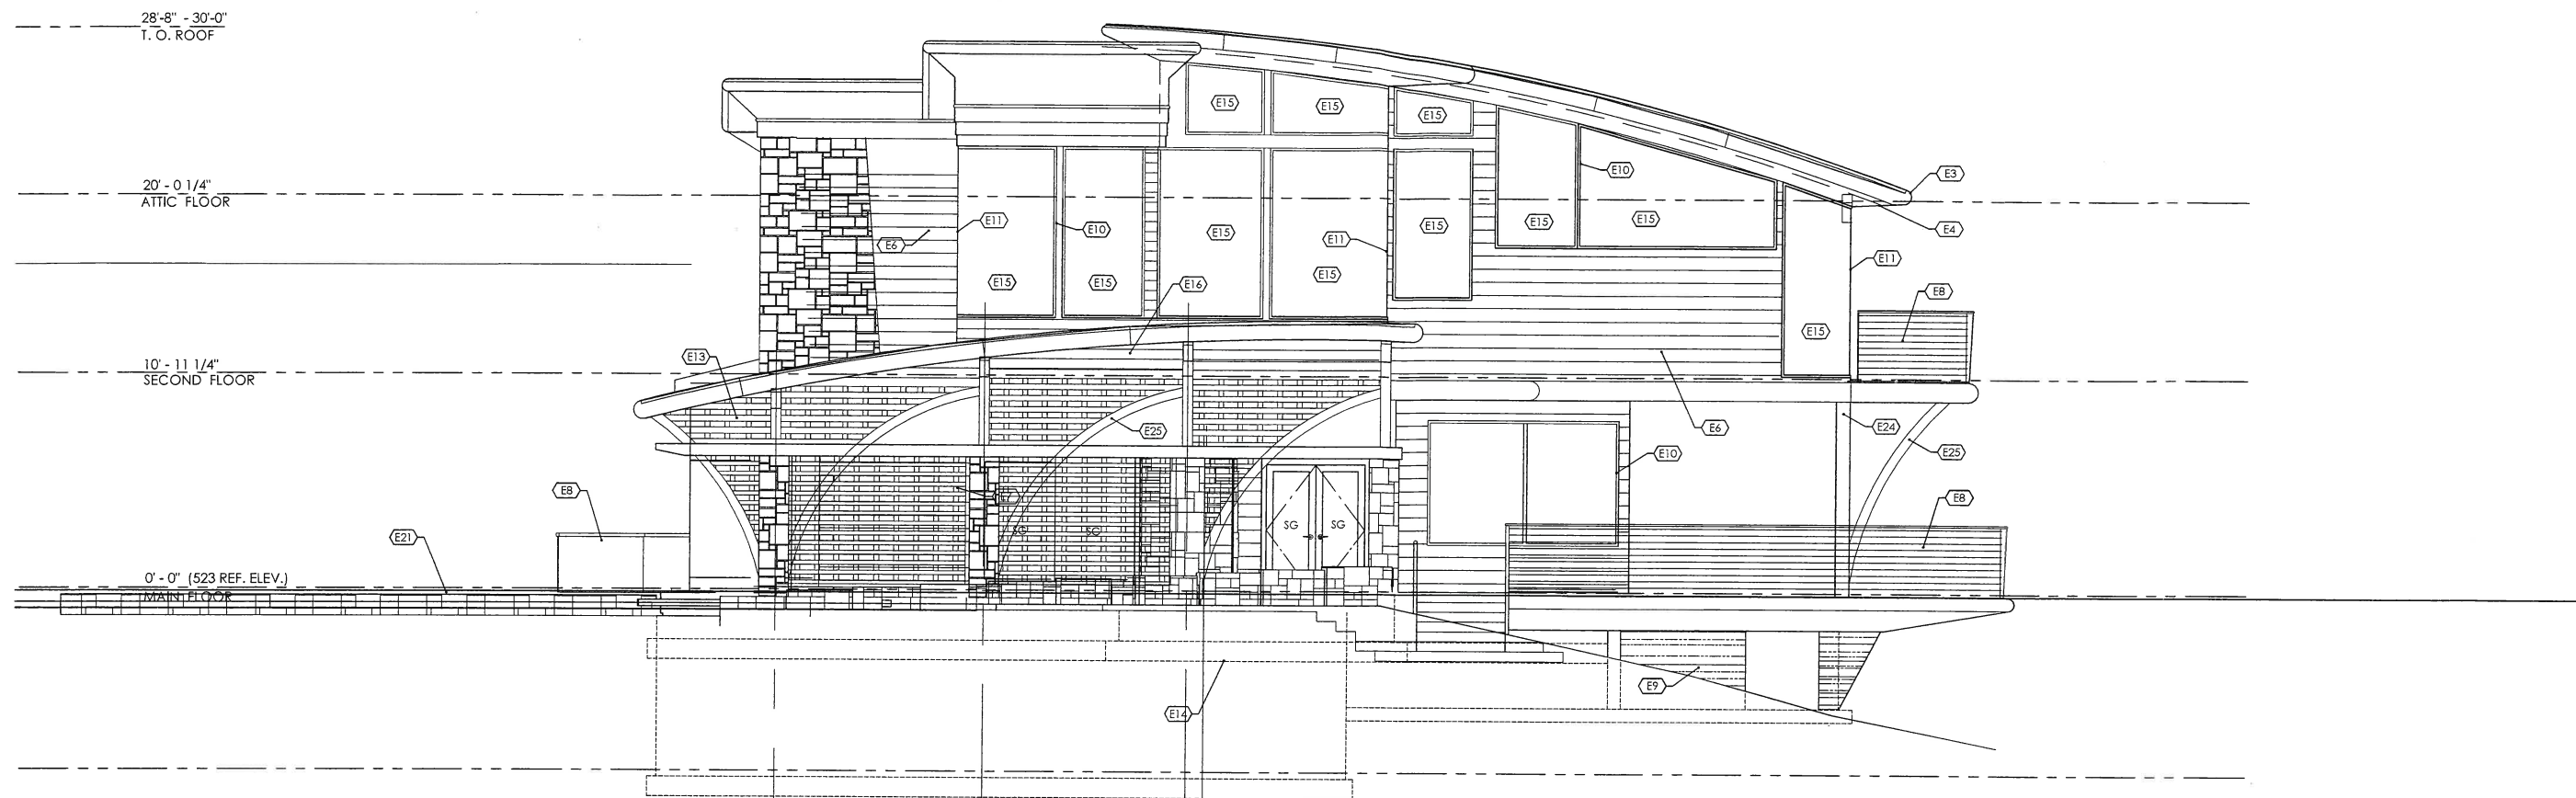

NORTH ELEVATION
SCALE: 1/4" = 1' - 0"

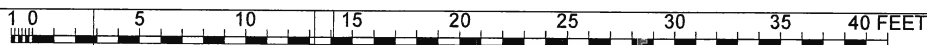

LEGEND

- E1. STANDING SEAM METAL ROOF TYP.
- E2. PHOTO VOLTAIC PANELS SIZE & # TBD.
- E3. CUSTOM METAL GUTTER / FASCIA DTL.
- E4. FIBER CEMENT SOFFIT DTL. W/ DRY PIPE FIRE SPRINKLER SYSTEM.
- E5. METAL & FIBER CEMENT RAKE, W/ EQUALLY SPACED JOINTS.
- E6. FIBER CEMENT RAIN SCREEN.
- E7. RANDOM ASHLAR SYNTHETIC STONE VENEER.
- E8. 42" HIGH GUARDRAIL W/ WIRE ROPE AT 3 1/2" O/C. SEE DTL.
- E9. OFF FORM CONCRETE WALL.
- E10. PREMANUF. METAL FRAME DOOR & WINDOW SYSTEM TYP.
- E11. BUTT GLAZED WINDOWS WHERE SHOWN.
- E12. SG = SAFETY GLAZING WHERE SHOWN.

- E13. EXTRUDED ALUMINUM TRELLIS SYSTEM SEE DTL.
- E14. BELOW GRADE FOUNDATION WORK SHOWN DASHED TYP.
- E15. REFLECTIVE PRIVACY GLAZING WHERE SHOWN.
- E16. STRUCTURAL BEAM W/ DRIP FLASHING FINISH TBD.
- E17. EXISTING GRADE AT BUILDING CENTER SHOWN DASHED.
- E18. 9'-0" X 7'-0" GARAGE DOOR.
- E19. 7'-0" X 7'-0" GARAGE DOOR.
- E20. 6' HIGH MAX. LANDSCAPE RETAINING WALLS WITH OFF FORM CONCRETE FINISH TYP. W/ STONE CAPS WHERE SHOWN.
- E21. LANDSCAPE STAIRS & FEATURE WALLS W/ STONE CAPS TBD.
- E23. MATCH EXISTING DECK MATERIAL & DIRECTION.
- E24. STEEL MOMENT FRAME


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DESIGN DATE: 4 DEC 2019

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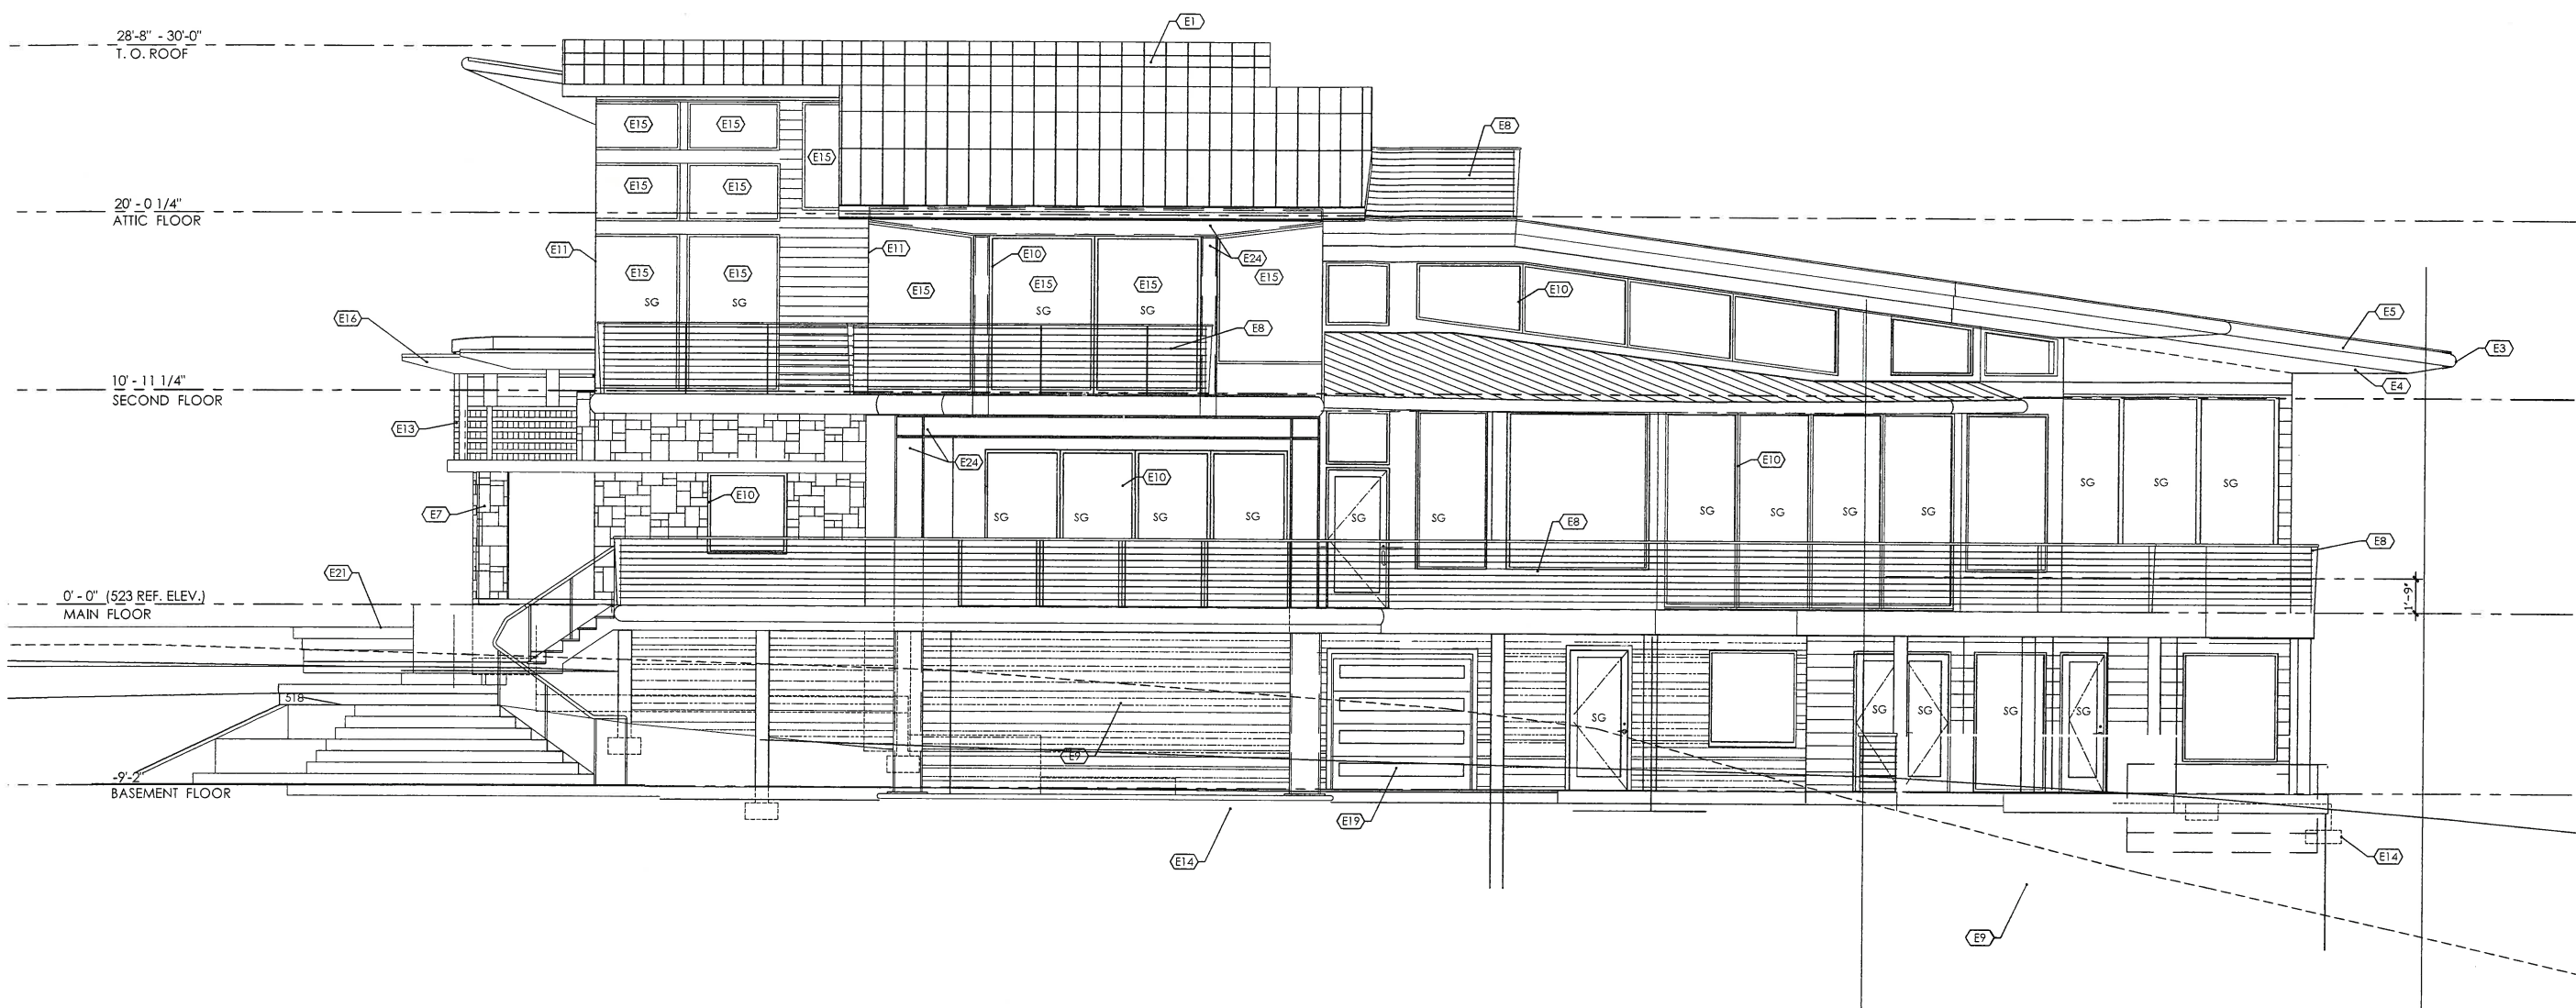
SCALE:

FILE NAME:




SHEET NO. A8

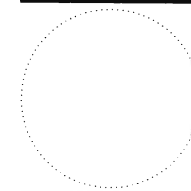OF



WEST ELEVATION
SCALE: 1/4" = 1'-0"

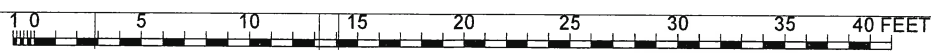

- LEGEND**
- E1. STANDING SEAM METAL ROOF TYP.
 - E2. PHOTO VOLTAIC PANELS SIZE & # TBD.
 - E3. CUSTOM METAL GUTTER / FASCIA DTL.
 - E4. FIBER CEMENT SOFFIT DTL. W/ DRY PIPE FIRE SPRINKLER SYSTEM.
 - E5. METAL & FIBER CEMENT RAKE, W/ EQUALLY SPACED JOINTS.
 - E6. FIBER CEMENT RAIN SCREEN.
 - E7. RANDOM ASHLAR SYNTHETIC STONE VENEER.
 - E8. 42" HIGH GUARDRAIL W/ WIRE ROPE AT 3 1/2" O/C. SEE DTL.
 - E9. OFF FORM CONCRETE WALL.
 - E10. PREMANUF. METAL FRAME DOOR & WINDOW SYSTEM TYP.
 - E11. BUTT GLAZED WINDOWS WHERE SHOWN.
 - E12. SG = SAFETY GLAZING WHERE SHOWN.
 - E13. EXTRUDED ALUMINUM TRELLIS SYSTEM. SEE DTL.
 - E14. BELOW GRADE FOUNDATION WORK SHOWN DASHED TYP.
 - E15. REFLECTIVE PRIVACY GLAZING WHERE SHOWN.
 - E16. STRUCTURAL BEAM W/ DRIP FLASHING FINISH TBD.
 - E17. EXISTING GRADE AT BUILDING CENTER SHOWN DASHED.
 - E18. 9'-0" X 7'-0" GARAGE DOOR.
 - E19. 7'-0" X 7'-0" GARAGE DOOR.
 - E20. 6" HIGH MAX. LANDSCAPE RETAINING WALLS WITH OFF FORM CONCRETE FINISH TYP. W/ STONE CAPS WHERE SHOWN.
 - E21. LANDSCAPE STAIRS & FEATURE WALLS W/ STONE CAPS TBD.
 - E23. MATCH EXISTING DECK MATERIAL & DIRECTION.
 - E24. STEEL MOMENT FRAME.

WAIBLINGER RESIDENCE
 13195 NW McNamee Rd.
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DESIGN DATE: 4 DEC 2019


DRAWN BY: CAL

SHEET NO. A9

OF

CLINTON
PEARSON
ARCHITECT


STREET ADDRESS:
11076 SW ESCHMAN WAY
TIGARD, OREGON 97223
PHONE:
971-570-1606

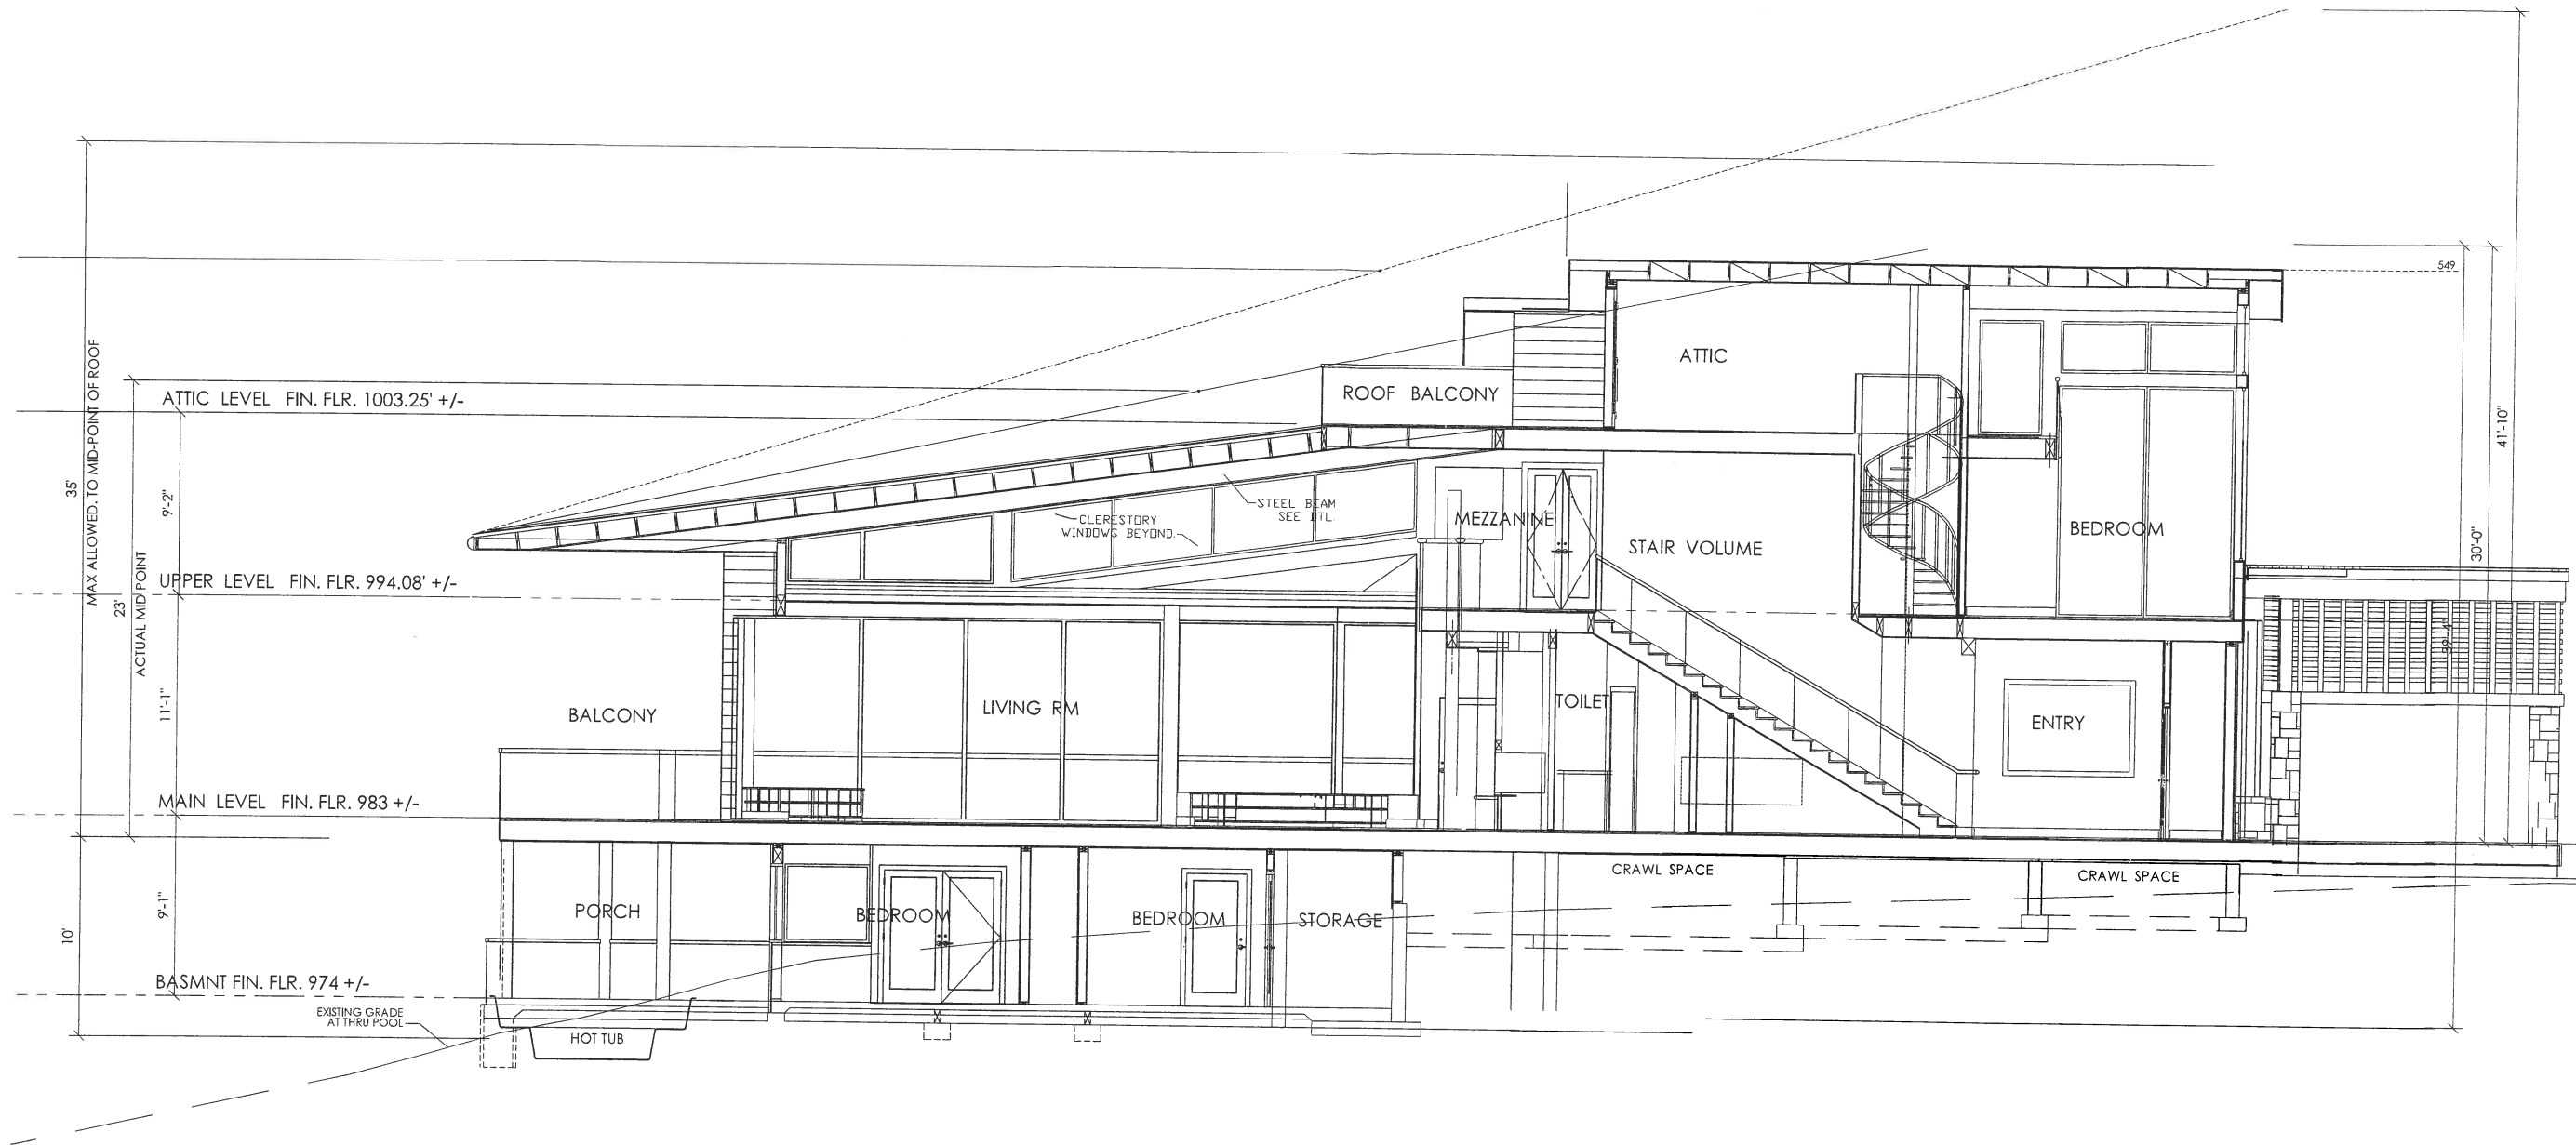

WAIBLINGER RESIDENCE
13195 NW M c Name Rd.
PORTLAND, OREGON

SECTION "CC"
SCALE: 1/4" = 1'-0"

DESIGN DATE: 4 DEC 2019
DRAWN BY: CAL
SCALE:
FILE NAME:

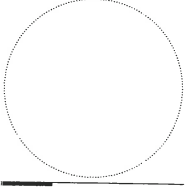

SHEET NO. **A10**
OF