



1 ACCESS ROAD PLAN
C1.30 SCALE 1"=30'

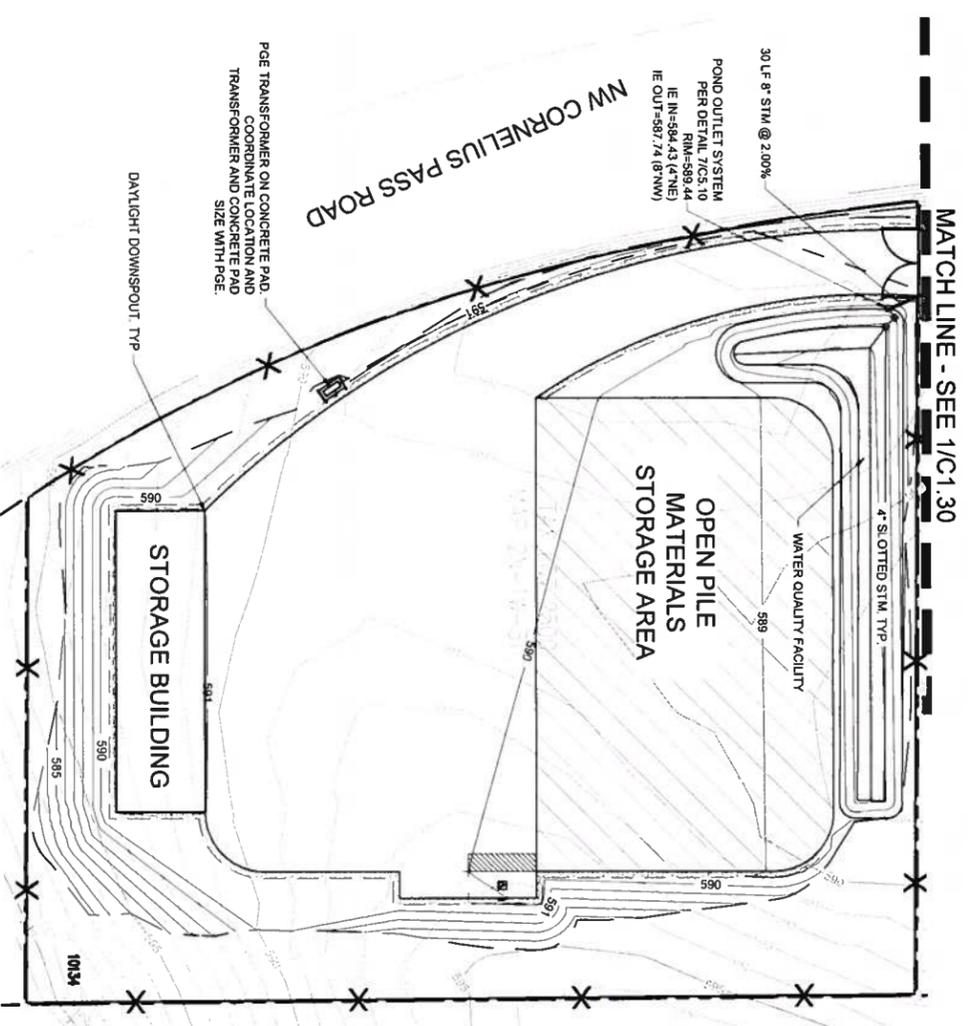

2 UTILITY PLAN
C1.30 SCALE 1"=30'

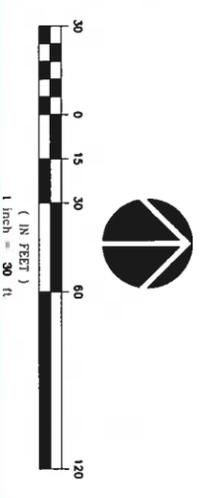

Architecture - Interiors
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Client
**OREGON
DEPARTMENT OF
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9200 SW LAWNFIELD
ROAD
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Project
**SKYLINE ROAD
STOCKPILE SITE**



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REVISIONS SCHEDULE		
Date	Issued As	Issue Date

SHEET TITLE
UTILITY PLAN

DRAWN BY: BWR
CHECKED BY: BON
SHEET

C1.30

JOB NO. **2200357.00**

PRELIMINARY ONLY
2025700 DRAWINGS CIVIL 357 - C1.30 DWG BWR 01/19/21 1224 130



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Date	Issued As	Issue Date

SHEET TITLE
CIVIL DETAILS


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 CHECKED BY: BDN
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C5.10

JOB NO. **2200357.00**

PRELIMINARY ONLY


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- KEYNOTES**
1. ASPHALT PAVEMENT SECTION PER PROJECT SPECIFICATIONS
 2. CRUSHED ROCK BASE SECTION PER PROJECT SPECIFICATIONS
 3. COMPACTED SUBGRADE PER GEOTECHNICAL RECOMMENDATIONS
- NOTES**
- A. SEE PROJECT GEOTECHNICAL REPORT FOR PAVEMENT AND SUBGRADE PREPARATION RECOMMENDATIONS

1 ASPHALT PAVEMENT SECTION

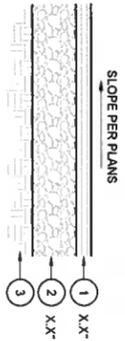
NTS



- KEYNOTES**
1. CRUSHED ROCK BASE SECTION PER PROJECT SPECIFICATIONS
 2. COMPACTED SUBGRADE PER GEOTECHNICAL RECOMMENDATIONS
- NOTES**
- A. SEE PROJECT GEOTECHNICAL REPORT FOR PAVEMENT AND SUBGRADE PREPARATION RECOMMENDATIONS

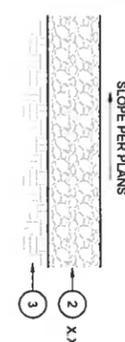2 GRAVEL SURFACING SECTION


NTS

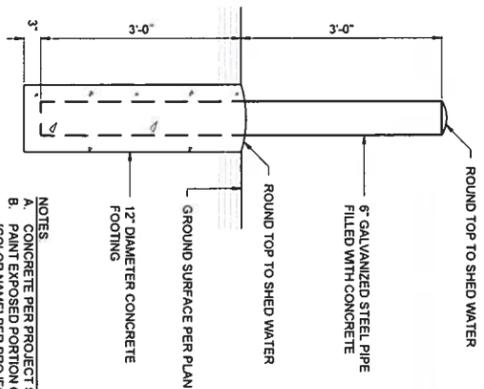

- NOTES**
- A. CONCRETE PER PROJECT SPECIFICATIONS
 B. PAINT EXPOSED PORTION OF BOLLARD (COLOR NAME) PER PROJECT SPECIFICATIONS

4 6" PIPE BOLLARD


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- KEYNOTES**
1. EXISTING OR FINISHED GRADE PER PLANS
 2. 30" LONG, PERFORATED GALVANIZED 12GA METAL POST SLEEVE SIZED TO ACCOMMODATE 2"x2" SQUARE POST. EMBED ABOVE GRADE TO APPROXIMATELY 7" IS EXPOSED ABOVE GRADE TO ALLOW FOR INSTALLATION OF THE CORNER BOLT
 3. IN THE TOP PERFORATED GALVANIZED 12GA METAL SIGN POST, DRIBBLE TUBES OR EQUAL, SIGN POST SHALL BE EMBEDDED A MINIMUM OF 12" INTO THE POST SLEEVE. CONTRACTOR TO VERIFY REQUIRED POST LENGTH PRIOR TO ORDERING.
 4. ATTACH SIGN TO PERFORATED POST USING A MINIMUM OF 2 DRIVE RIVETS THROUGH THE FACE OF THE SIGN, SIZE, SHAPE, AND WORDING OF SIGN PER PLANS OR SEPARATE DETAIL.
- NOTES**
- A. SIGN POST SHALL BE PLACED SUCH THAT EDGE OF MOUNTED SIGN IS AT LEAST 24" AWAY FROM ANY ADJACENT ROADWAY

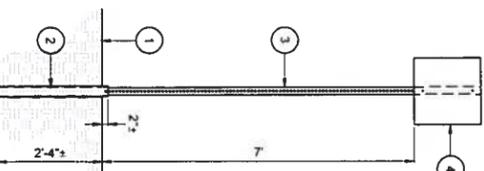5 SIGN POST


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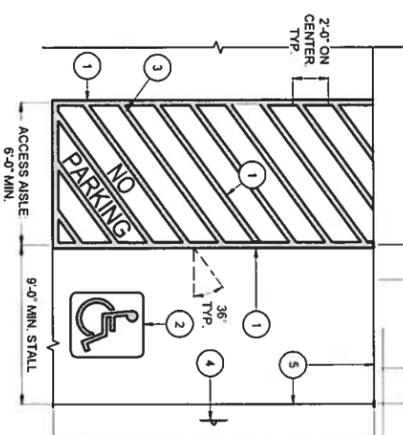
- KEYNOTES**
1. PIPE SIZE AND INVERT PER PLAN. WHERE NOT NOTED, PIPE SHALL DISCHARGE 6-12" ABOVE RIP RAP.
 2. FINISHED GRADE AND SLOPE PER PLAN. PLANTING PER LANDSCAPE PLANS.
 3. CRUSHED ANGULAR 6-10" DIAMETER ROCK (IE. DOT CLASS 50 RIP RAP). TOP OF RIP RAP LAYER SHALL SUPERSEDE THOSE SHOWN ON THIS DETAIL. DIAMETER (DIA) REFERENCES REFER TO THE INSIDE DIAMETER OF THE OUTFALL PIPE.
 4. WOVEN FILTER FABRIC ENCASING ALL BUT THE TOP SURFACE OF THE RIP RAP.

3 PIPE OUTFALL - RIP RAP

NTS

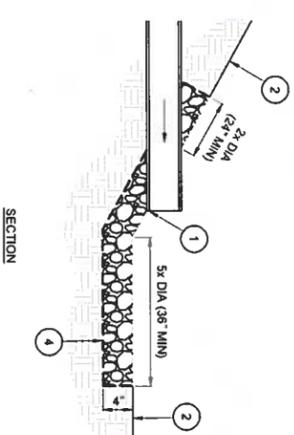


ISOMETRIC

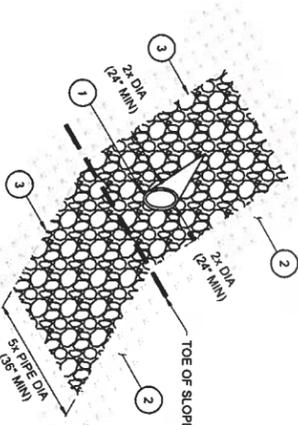


- KEYNOTES**
1. 4" WIDE WHITE STRIPE
 2. WHITE RETROREFLECTIVE PAVEMENT MARKING SYMBOL (FHWA 3B-22) WITH BLUE RETROREFLECTIVE BACKGROUND (4" TALL x 36" WIDE WITH 4" STROKE WIDTH), OFFSET BACKGROUND LIMIT 4" FROM SYMBOL
 3. YELLOW RETROREFLECTIVE NO PARKING (PAVEMENT MARKING LEGEND TWO) SHALL BE 12" TALL x 18" WIDE AND MARKINGS SHALL BE 12" ACCESSIBLE PARKING SPACE SIGNAGE PER DETAIL, HEREON
 4. MAINTAIN 48" CLEAR ACCESS AROUND SIGN, ENSURE NO INTERFERENCE WITH PARKING STALL OVERHANG
 5. EDGE OF PAVEMENT

6 ACCESSIBLE PARKING STALL

NTS

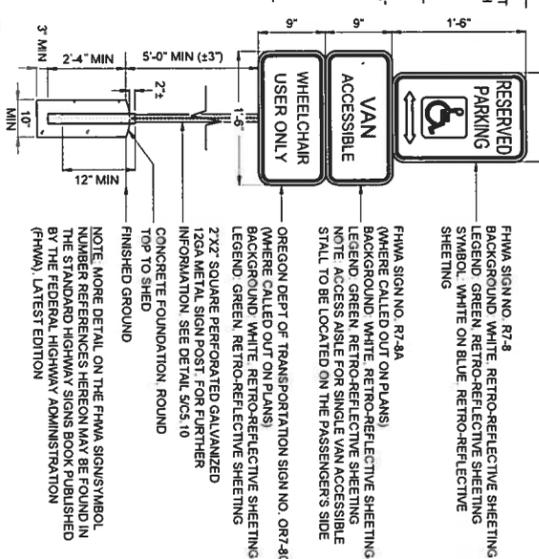

- FHWA SIGN NO. R7-8
 (WHERE CALLED OUT ON PLANS)
 BACKGROUND WHITE, RETRO-REFLECTIVE SHEETING
 LEGEND GREEN, RETRO-REFLECTIVE SHEETING SYMBOL, WHITE ON BLUE, RETRO-REFLECTIVE SHEETING
- FHWA SIGN NO. R7-8A
 (WHERE CALLED OUT ON PLANS)
 BACKGROUND WHITE, RETRO-REFLECTIVE SHEETING
 LEGEND GREEN, RETRO-REFLECTIVE SHEETING
 NOTE: ACCESS AISLE FOR SINGLE VAN ACCESSIBLE STALL TO BE LOCATED ON THE PASSENGER'S SIDE
- OREGON DEPT. OF TRANSPORTATION SIGN NO. OR7-3C
 (WHERE CALLED OUT ON PLANS)
 BACKGROUND WHITE, RETRO-REFLECTIVE SHEETING
 LEGEND GREEN, RETRO-REFLECTIVE SHEETING
 2"x2" SQUARE PERFORATED GALVANIZED 12GA METAL SIGN POST, FOR FURTHER INFORMATION, SEE DETAIL, C5.10
- CONCRETE FOUNDATION: ROUND TOP TO SHED
- FINISHED GROUND
- NOTE: MORE DETAIL ON THE FHWA SIGN SYMBOL NUMBER REFERENCES HEREON MAY BE FOUND IN THE STANDARD HIGHWAY SIGNS BOOK PUBLISHED BY THE FEDERAL HIGHWAY ADMINISTRATION (FHWA), LATEST EDITION

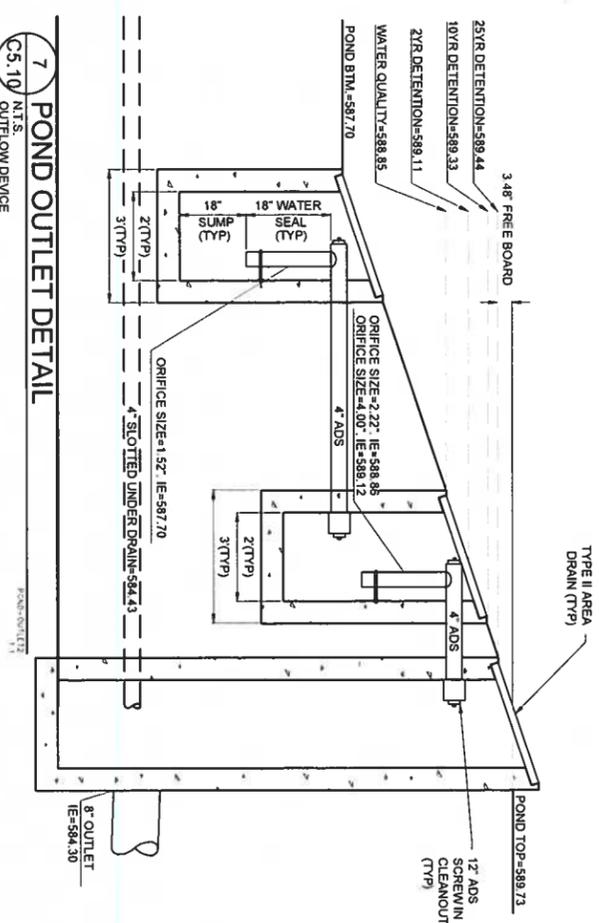

7 POND OUTLET DETAIL

NTS